



ARCHITECT OF RECORD
DMJM H&N | AECOM
 405 HOWARD STREET, SUITE 400
 SAN FRANCISCO, CALIFORNIA 94105
 T 415.365.3200 F 415.267.4957 www.dmjmh&n.com

DESIGN ARCHITECTS
WILLIAM MCDONOUGH + PARTNERS
 Architecture + Community Design
 700 EAST JEFFERSON STREET
 CHARLOTTESVILLE, VIRGINIA 22902
 T 434.979.1111 F 434.979.1112 www.mcdonoughpartners.com

CONSULTANTS
CIVIL ENGINEER:
 AECOM TRANSPORTATION
 999 TOWN AND COUNTRY ROAD
 ORANGE, CALIFORNIA 92668
 T 714.567.2752 F 714.567.2729
LANDSCAPE ARCHITECT:
 EDAAW
 2737 CAMPUS DRIVE
 IRVINE, CA 92612
 T 949.660.8044 F 949.660.1046
A/E OF RECORD:
 AECOM
 999 TOWN AND COUNTRY ROAD
 ORANGE, CALIFORNIA 92668
 T 714.567.2752 F 714.567.2729

ARCHITECT/ENGINEER STAMP

NASA AMES RESEARCH CENTER N232 COLLABORATIVE SUPPORT FACILITY

BUILDING N232 - BUSH CIRCLE
 MOUNTAIN VIEW, CALIFORNIA 94035

| | | | |
|--|------------|--------------------|---------|
| PROJECT STATUS | | BID SET 04/30/09 | |
| ISSUE | | | |
| MARK | DATE | DESCRIPTION | INITIAL |
| DRAWN | G JOHNSON | DATE | |
| DESIGNED | R PRADHAN | DATE | |
| CHECKED | W JOFFRION | DATE | |
| PROJECT MGR | J GRANT | DATE | |
| REQUESTOR | R SCHULER | DATE | |
| R&GA | | DATE | |
| SAFETY | | DATE | |
| SUPERVISOR | S FRANKEL | DATE | |
|  Ames Research Center Moffet Field, California N232 COLLABORATIVE SUPPORT FACILITY | | COVER SHEET | |
| | | | |

4/30/2009 1:16:44 PM

NASA N232 SHEET INDEX

4/30/2009
SHEET NUMBER
SHEET TITLE

| Project Phases | | | |
|----------------|----------------|--|--|
| BID SET | April 30, 2009 | | |
| | | | |
| | | | |
| | | | |

SHEET NUMBER
SHEET TITLE

| Project Phases | | | |
|----------------|----------------|--|--|
| BID SET | April 30, 2009 | | |
| | | | |
| | | | |
| | | | |

SHEET NUMBER
SHEET TITLE

| Project Phases | | | |
|----------------|----------------|--|--|
| BID SET | April 30, 2009 | | |
| | | | |
| | | | |
| | | | |

SHEET NUMBER
SHEET TITLE

GENERAL

| | | | | | |
|------|--|--|--|--|--|
| G000 | COVER | | | | |
| G001 | SHEET INDEX | | | | |
| G002 | PROJECT INFORMATION | | | | |
| G100 | ACCESSIBILITY SITE PLAN | | | | |
| G101 | OVERALL SPACE PLAN - FIRST FLOOR (NIC, FOR REFERENCE ONLY) | | | | |
| G102 | OVERALL SPACE PLAN - 2ND FLOOR (NIC, FOR REFERENCE ONLY) | | | | |

CIVIL

| | | | | | |
|------|----------------------------------|--|--|--|--|
| C001 | CIVIL ABBREVIATIONS & LEGEND | | | | |
| C011 | EXISTING TOPOGRAPHIC SURVEY PLAN | | | | |
| C101 | DEMOLITION PLAN | | | | |
| C201 | SITE PLAN | | | | |
| C301 | GRADING PLAN | | | | |
| C302 | GRADING PLAN | | | | |
| C303 | GRADING PLAN | | | | |
| C304 | GRADING PLAN | | | | |
| C381 | EROSION CONTROL PLAN | | | | |
| C401 | UTILITY PLAN | | | | |
| C901 | CIVIL DETAILS | | | | |
| C902 | CIVIL DETAILS | | | | |
| C903 | CIVIL DETAILS | | | | |

LANDSCAPE

| | | | | | |
|------|--|--|--|--|--|
| L100 | CONSTRUCTION NOTES, LEGEND & SCHEDULES | | | | |
| L101 | SITE CONSTRUCTION PLAN | | | | |
| L401 | CONSTRUCTION DETAILS | | | | |
| L402 | CONSTRUCTION DETAILS | | | | |
| L403 | CONSTRUCTION DETAILS | | | | |
| L500 | IRRIGATION NOTES AND LEGENDS | | | | |
| L501 | IRRIGATION PLAN | | | | |
| L502 | IRRIGATION DETAILS | | | | |
| L551 | IRRIGATION DETAILS | | | | |
| L552 | IRRIGATION DETAILS | | | | |
| L553 | IRRIGATION DETAILS | | | | |
| L554 | IRRIGATION PUMP AND STORAGE TANK DETAILS | | | | |
| L555 | IRRIGATION NOTES AND DATA | | | | |
| L600 | PLANTING NOTES | | | | |
| L601 | PLANTING LEGEND & SCHEDULE | | | | |
| L602 | TREE PLANTING PLAN | | | | |
| L603 | SHRUB PLANTING PLAN | | | | |
| L604 | SHRUB PLANTING PLAN | | | | |
| L605 | SHRUB PLANTING PLAN | | | | |
| L606 | SHRUB PLANTING PLAN | | | | |
| L651 | PLANTING DETAILS | | | | |

ARCHITECTURAL

| | | | | | |
|------|---|--|--|--|--|
| A001 | ABBREVIATIONS, SYMBOLS & GENERAL NOTES | | | | |
| A002 | ACCESSIBILITY COMPLIANCE AND DETAILS | | | | |
| A011 | FIRE RATED WALLS & EGRESS PLAN - FIRST FLOOR | | | | |
| A012 | FIRE RATED WALLS & EGRESS PLAN - SECOND FLOOR | | | | |
| A100 | ARCHITECTURAL SITE PLAN & COL. GRID PLAN | | | | |
| A101 | PARTITION TYPES & DETAILS | | | | |
| A102 | DOOR & LOUVER SCHEDULE & DETAILS | | | | |
| A103 | CURTAIN WALL TYPES | | | | |
| A104 | WINDOW SHADE TYPES | | | | |
| A105 | FINISH SCHEDULE | | | | |
| A106 | VERTICAL SHADE LOUVER TYPES | | | | |
| A107 | HORIZONTAL SHADE TYPES | | | | |
| A110 | ARCHITECTURAL KEY PLAN | | | | |
| A111 | FIRST FLOOR SLAB PLAN - NORTH WING | | | | |
| A112 | FIRST FLOOR SLAB PLAN - SOUTH WING | | | | |
| A121 | SECOND FLOOR SLAB PLAN - NORTH WING | | | | |
| A122 | SECOND FLOOR SLAB PLAN - SOUTH WING | | | | |
| A211 | FIRST FLOOR PLAN - NORTH WING | | | | |
| A212 | FIRST FLOOR PLAN - SOUTH WING | | | | |
| A221 | SECOND FLOOR PLAN - NORTH WING | | | | |
| A222 | SECOND FLOOR PLAN - SOUTH WING | | | | |
| A231 | ROOF PLAN - NORTH WING | | | | |
| A232 | ROOF PLAN - SOUTH WING | | | | |
| A241 | FIRST FLOOR RCP - NORTH WING | | | | |
| A242 | FIRST FLOOR RCP - SOUTH WING | | | | |
| A251 | SECOND FLOOR RCP - NORTH WING | | | | |
| A252 | SECOND FLOOR RCP - SOUTH WING | | | | |
| A261 | FIRST FLOOR WINDOW SHADE PLAN - NORTH WING | | | | |
| A262 | FIRST FLOOR WINDOW SHADE PLAN - SOUTH WING | | | | |
| A271 | SECOND FLOOR WINDOW SHADE PLAN - NORTH WING | | | | |
| A272 | SECOND FLOOR WINDOW SHADE PLAN - SOUTH WING | | | | |
| A301 | EXTERIOR ELEVATIONS - NORTH WING | | | | |
| A302 | EXTERIOR ELEVATIONS - SOUTH WING | | | | |
| A303 | ENLARGED EXTERIOR ELEVATIONS | | | | |
| A311 | BUILDING SECTIONS | | | | |
| A312 | BUILDING SECTIONS | | | | |
| A501 | WALL SECTIONS | | | | |
| A502 | WALL SECTIONS | | | | |
| A503 | WALL SECTIONS | | | | |
| A611 | ENLARGED PLAN, ELEVATION & SECTION - CONNECTOR | | | | |
| A612 | ENLARGED PLAN, ELEVATION & SECTION - LUNCH ROOM | | | | |
| A613 | ENLARGED PLAN, ELEVATION & SECTION - LOBBY | | | | |
| A614 | ENLARGED TYPICAL BAY CEILING PLAN | | | | |
| A621 | ENLARGED PLAN & SECTION - STAIR 1 | | | | |
| A622 | ENLARGED PLAN & SECTION - STAIR 2 | | | | |
| A623 | ENLARGED PLAN & SECTION - STAIR 3 | | | | |
| A624 | STAIR 1 ELEVATIONS & DETAILS | | | | |
| A631 | ENLARGED PLAN & SECTIONS - ELEVATOR | | | | |
| A632 | ENLARGED PLANS & INTERIOR ELEVATIONS - SOUTH LOBBY & ELEVATOR | | | | |
| A641 | ENLARGED PLANS & INTERIOR ELEVATIONS - RESTROOMS | | | | |
| A642 | INTERIOR ELEVATIONS - RESTROOMS | | | | |
| A643 | RESTROOM DETAILS | | | | |

ARCHITECTURAL cont'd

| | | | | | |
|------|--|--|--|--|--|
| A701 | EXTERIOR DETAILS | | | | |
| A702 | EXTERIOR DETAILS | | | | |
| A703 | EXTERIOR DETAILS | | | | |
| A704 | EXTERIOR DETAILS | | | | |
| A705 | VERTICAL & HORIZONTAL SHADE DETAILS | | | | |
| A711 | EXTERIOR PANEL DETAILS | | | | |
| A712 | EXTERIOR OPENING DETAILS | | | | |
| A713 | CURTAIN WALL DETAILS | | | | |
| A721 | ROOF DETAILS | | | | |
| A731 | CONNECTOR DETAILS | | | | |
| A751 | STAIR - RAILING DETAILS | | | | |
| A752 | STAIR DETAILS | | | | |
| A761 | INTERIOR NON-LOAD BEARING LIGHT GAGE STEEL FRAMING | | | | |
| A801 | EDGE OF SLAB DETAILS | | | | |
| A802 | INTERIOR DETAILS | | | | |
| A804 | CEILING DETAILS | | | | |
| A811 | SIGNAGE DETAILS | | | | |

STRUCTURAL

| | | | | | |
|------|---|--|--|--|--|
| S001 | GENERAL NOTES, SYMBOLS, AND ABBREVIATIONS | | | | |
| S002 | STANDARD QUALITY ASSURANCE PLAN FOR SPECIAL MOMENT FRAMES | | | | |
| S003 | TEST, INSPECTIONS AND OBSERVATIONS | | | | |
| S004 | SPECIAL INSPECTIONS FOR SPECIAL MOMENT FRAMES | | | | |
| S005 | TYPICAL DETAILS | | | | |
| S006 | TYPICAL DETAILS FOR SPECIAL MOMENT FRAMES | | | | |
| S007 | TYPICAL DETAILS | | | | |
| S008 | TYPICAL DETAILS | | | | |
| S009 | TYPICAL DETAILS | | | | |
| S211 | PARTIAL FOUNDATION PLAN - NORTH WING | | | | |
| S212 | PARTIAL FOUNDATION PLAN - SOUTH WING | | | | |
| S221 | PARTIAL SECOND FLOOR FRAMING PLAN - NORTH WING | | | | |
| S222 | PARTIAL SECOND FLOOR FRAMING PLAN - SOUTH WING | | | | |
| S231 | PARTIAL ROOF FRAMING PLAN - NORTH WING | | | | |
| S232 | PARTIAL ROOF FRAMING PLAN - SOUTH WING | | | | |
| S301 | TYPICAL CURTAIN WALL ELEVATIONS AND DETAILS | | | | |
| S311 | BUILDING SECTIONS AND DETAILS | | | | |
| S501 | SECTIONS AND DETAILS | | | | |
| S502 | SECTIONS AND DETAILS | | | | |
| S503 | DETAILS | | | | |
| S601 | ENLARGED PLANS AND DETAILS | | | | |
| S602 | ENLARGED PLANS AND DETAILS | | | | |
| S701 | DETAILS | | | | |

FIRE ALARM

| | | | | | |
|-------|--|--|--|--|--|
| FA001 | FIRE ALARM LEGEND AND ABBREVIATIONS | | | | |
| FA211 | FIRST FLOOR FIRE ALARM PLAN - NORTH WING | | | | |
| FA212 | FIRST FLOOR FIRE ALARM PLAN - SOUTH WING | | | | |
| FA213 | SECOND FLOOR FIRE ALARM PLAN - NORTH WING | | | | |
| FA214 | SECOND FLOOR FIRE ALARM PLAN - SOUTH WING | | | | |
| FA215 | ROOF PLAN FIRE ALARM PLAN - NORTH WING | | | | |
| FA216 | ROOF PLAN FIRE ALARM PLAN - SOUTH WING | | | | |
| FA401 | FIRE ALARM / MASS NOTIFICATION RISER DIAGRAM | | | | |
| FA402 | GRAPHIC ANNUNCIATOR PANEL | | | | |
| FA501 | FIRE ALRM DETAILS | | | | |

FIRE PROTECTION

| | | | | | |
|-------|--|--|--|--|--|
| FP001 | FIRE PROTECTION LEGEND AND ABBREVIATIONS | | | | |
| FP110 | FIRE PROTECTION SINGLE LINE DIAGRAM | | | | |
| FP211 | FIRE PROTECTION PARTIAL FIRST FLOOR PLAN - NORTH WING | | | | |
| FP212 | FIRE PROTECTION PARTIAL SECOND FLOOR PLAN - SOUTH WING | | | | |
| FP221 | FIRE PROTECTION PARTIAL SECOND FLOOR PLAN - NORTH WING | | | | |
| FP222 | FIRE PROTECTION PARTIAL SECOND FLOOR PLAN - SOUTH WING | | | | |
| FP401 | FIRE PROTECTION DETAILS | | | | |

MECHANICAL

| | | | | | |
|------|---|--|--|--|--|
| M001 | MECHANICAL LEGEND & SYMBOLS | | | | |
| M002 | MECHANICAL ABBREVIATIONS & GENL. NOTES | | | | |
| M110 | HVAC FLOW & CONTROL DIAGRAMS | | | | |
| M111 | HVAC FLOW & CONTROL DIAGRAMS | | | | |
| M112 | HVAC FLOW & CONTROL DIAGRAMS | | | | |
| M113 | HVAC CONTROLS | | | | |
| M114 | CONTROLS SEQUENCE OF OPERATIONS | | | | |
| M140 | GEO THERMAL PIPING SITE PLAN | | | | |
| M211 | LOW LEVEL MECHANICAL PARTIAL FIRST FLOOR PLAN - NORTH WING | | | | |
| M212 | LOW LEVEL MECHANICAL PARTIAL FIRST FLOOR PLAN - SOUTH WING | | | | |
| M221 | LOW LEVEL MECHANICAL PARTIAL 2ND FLOOR PLAN - NORTH WING | | | | |
| M222 | LOW LEVEL MECHANICAL PARTIAL 2ND FLOOR PLAN - SOUTH WING | | | | |
| M231 | MECHANICAL PARTIAL ROOF PLAN - NORTH WING | | | | |
| M232 | MECHANICAL PARTIAL ROOF PLAN - SOUTH WING | | | | |
| M241 | HIGH LEVEL MECHANICAL PARTIAL FIRST FLOOR PLAN - NORTH WING | | | | |
| M242 | HIGH LEVEL MECHANICAL PARTIAL FIRST FLOOR PLAN - SOUTH WING | | | | |
| M251 | HIGH LEVEL MECHANICAL PARTIAL 2ND FLOOR PLAN - NORTH WING | | | | |
| M252 | HIGH LEVEL MECHANICAL PARTIAL 2ND FLOOR PLAN - SOUTH WING | | | | |
| M301 | MECHANICAL SECTIONS | | | | |
| M302 | PARTIAL PLAN - MECHANICAL EQUIPMENT ROOM | | | | |
| M303 | FIRST FLOOR MECHANICAL ROOM - SECTIONS | | | | |
| M304 | MECHANICAL SECTIONS | | | | |
| M305 | CEILING RADIANT COOLING PANEL PLAN (TYPICAL BAY) | | | | |
| M401 | MECHANICAL DETAILS | | | | |
| M402 | MECHANICAL PIPING DETAILS | | | | |
| M403 | MECHANICAL DETAILS | | | | |
| M404 | MECHANICAL DUCT DETAILS | | | | |
| M405 | MECHANICAL DETAILS | | | | |
| M501 | HVAC CONTROL DIAGRAMS WINDOWS | | | | |
| M502 | MECHANICAL CONTROL DIAGRAMS: BLINDS/LIGHTING | | | | |
| M601 | MECHANICAL EQUIPMENT SCHEDULES | | | | |
| M602 | MECHANICAL EQUIPMENT SCHEDULES | | | | |

PLUMBING

| | | | | | |
|------|--|--|--|--|--|
| P001 | PLUMBING LEGEND, ABBREVIATIONS & GENL. NOTES | | | | |
| P201 | PLUMBING KEY PLAN | | | | |
| P211 | PLUMBING PARTIAL FIRST FLOOR PLAN - NORTH WING | | | | |
| P212 | PLUMBING PARTIAL FIRST FLOOR PLAN - SOUTH WING | | | | |
| P221 | PLUMBING PARTIAL SECOND FLOOR PLAN - NORTH WING | | | | |
| P222 | PLUMBING PARTIAL SECOND FLOOR PLAN - SOUTH WING | | | | |
| P231 | PLUMBING PARTIAL ROOF PLAN - NORTH WING | | | | |
| P232 | PLUMBING PARTIAL ROOF PLAN - SOUTH WING | | | | |
| P301 | PLUMBING ENLARGED FLOOR PLANS - NORTH WING | | | | |
| P401 | PLUMBING OPEN LOOP SOLAR HOT WATER HEATING SYSTEM DETAIL | | | | |
| P402 | PLUMBING DETAILS | | | | |
| P403 | PLUMBING DETAILS | | | | |
| P404 | PLUMBING DETAILS | | | | |
| P501 | PLUMBING CALCULATION DIAGRAMS | | | | |
| P502 | PLUMBING CALCULATION & ISOMETRIC DIAGRAMS | | | | |
| P603 | WATER SUPPLY ISOMETRIC DIAGRAM | | | | |
| P601 | PLUMBING EQUIPMENT SCHEDULE | | | | |

ELECTRICAL

| | | | | | |
|------|---|--|--|--|--|
| E001 | ELECTRICAL SYMBOLS | | | | |
| E002 | ABBREVIATIONS & GENERAL NOTES | | | | |
| E110 | SUBSTATION SINGLE LINE RELAY DIAGRAM | | | | |
| E111 | SINGLE LINE DIAGRAM | | | | |
| E112 | SINGLE LINE DIAGRAM | | | | |
| E120 | FEEDER SCHEDULE | | | | |
| E121 | LIGHT FIXTURE SCHEDULE | | | | |
| E140 | ELECTRICAL POWER AND COMMUNICATIONS SITE PLAN | | | | |
| E141 | ELECTRICAL LIGHTING SITE PLAN | | | | |
| E311 | FIRST FLOOR LIGHTING PLAN - NORTH WING | | | | |
| E312 | FIRST FLOOR LIGHTING PLAN - SOUTH WING | | | | |
| E321 | SECOND FLOOR LIGHTING PLAN - NORTH WING | | | | |
| E322 | SECOND FLOOR LIGHTING PLAN - SOUTH WING | | | | |
| E331 | (NOT USED) | | | | |
| E332 | ROOF LIGHTING PLAN - SOUTH WING | | | | |
| E411 | FIRST FLOOR POWER PLAN - NORTH WING | | | | |
| E412 | FIRST FLOOR POWER PLAN - SOUTH WING | | | | |
| E421 | 2ND FLOOR POWER PLAN - NORTH WING | | | | |
| E422 | 2ND FLOOR POWER PLAN - SOUTH WING | | | | |
| E431 | ROOF POWER PLAN - NORTH WING | | | | |
| E432 | ROOF POWER PLAN - SOUTH WING | | | | |
| E511 | FIRST FLOOR COMMUNICATIONS PLAN - NORTH WING | | | | |
| E512 | FIRST FLOOR COMMUNICATIONS PLAN - SOUTH WING | | | | |
| E521 | 2ND FLOOR COMMUNICATIONS PLAN - NORTH WING | | | | |
| E522 | 2ND FLOOR COMMUNICATIONS PLAN - SOUTH WING | | | | |
| E611 | FIRST FLOOR SECURITY SYSTEMS PLAN - NORTH WING | | | | |
| E612 | FIRST FLOOR SECURITY SYSTEMS PLAN - SOUTH WING | | | | |
| E621 | SECOND FLOOR SECURITY SYSTEMS PLAN - NORTH WING | | | | |
| E622 | SECOND FLOOR SECURITY SYSTEMS PLAN - SOUTH WING | | | | |
| E801 | FIRST FLOOR ENLARGED POWER PLANS | | | | |
| E802 | SECOND FLOOR ENLARGED POWER PLANS | | | | |
| E901 | PANEL SCHEDULES | | | | |
| E902 | PANEL SCHEDULES | | | | |
| E903 | PANEL SCHEDULES | | | | |
| E904 | PANEL SCHEDULES | | | | |
| E905 | ELECTRICAL DETAILS | | | | |
| E906 | ELECTRICAL DETAILS | | | | |
| E907 | ELECTRICAL DETAILS | | | | |
| E908 | ELECTRICAL DETAILS | | | | |
| E909 | ELECTRICAL DETAILS | | | | |
| E910 | ELECTRICAL DETAILS | | | | |
| E911 | ELECTRICAL DETAILS | | | | |
| E912 | ELECTRICAL DETAILS | | | | |
| E913 | ELECTRICAL DETAILS | | | | |
| E914 | ELECTRICAL DETAILS | | | | |
| E915 | ELECTRICAL DETAILS | | | | |

PROJECT STATUS

BID SET 04/30/09


ISSUE

| MARK | DATE | DESCRIPTION | INITIAL |
|------|------|-------------|---------|
| | | | |
| | | | |

NOTES:
 PATH OF TRAVEL, AS INDICATED, IS A BARRIER-FREE ACCESS WITHOUT ANY ABRUPT VERTICAL CHANGES EXCEEDING 1/2" AT 1:2 MAXIMUM SLOPE, EXCEPT THAT LEVEL CHANGES DO NOT EXCEED 1/4" VERTICAL. SUCH PATH OF TRAVEL SHALL BE 48" MINIMUM WIDE BY 80" MINIMUM HIGH, SLIP-RESISTANT AND SHALL NOT EXCEED 2% CROSS-SLOPE. THE CONTRACTOR SHALL VERIFY THAT ALL BARRIERS ON THE INDICATED PATH OF TRAVEL HAVE BEEN REMOVED. PATH OF TRAVEL SHALL BE FREE FROM PROTRUDING OBJECTS GREATER THAN 4" PROJECTION FROM THE FACE OF WALL AND ABOVE 27" AND LESS THAN 80" ABOVE FINISHED FLOOR (CBC 1133.B.8.6). PATH OF TRAVEL SHALL COMPLY WITH CBC 1133B.

ALL EXTERIOR ENTRANCES AND EXITS INDICATED ON THE PATH OF TRAVEL LINE ON THIS PLAN ARE ACCESSIBLE AND COMPLY WITH CBC 1133B.1.1, INCLUDING:

- A. 32" CLEAR OPENING
- B. REQUIRED STRIKE EDGE CLEARANCE AT PULL SIDE OF DOOR (24" FOR FRONT AND LATCH, 36" FOR HINGE APPROACH)
- C. LEVEL LANDINGS (2% MAX SLOPE)
- D. ACCESSIBLE THRESHOLD, HARDWARE, CLOSER, KICK-PLATE
- E. INTERNATIONAL SYMBOL OF ACCESSIBILITY ON EXTERIOR SIDE OF ENTRANCE
- F. TACTILE EXIT SIGNAGE ON INTERIOR SIDE OF EXIT DOOR, AS REQUIRED

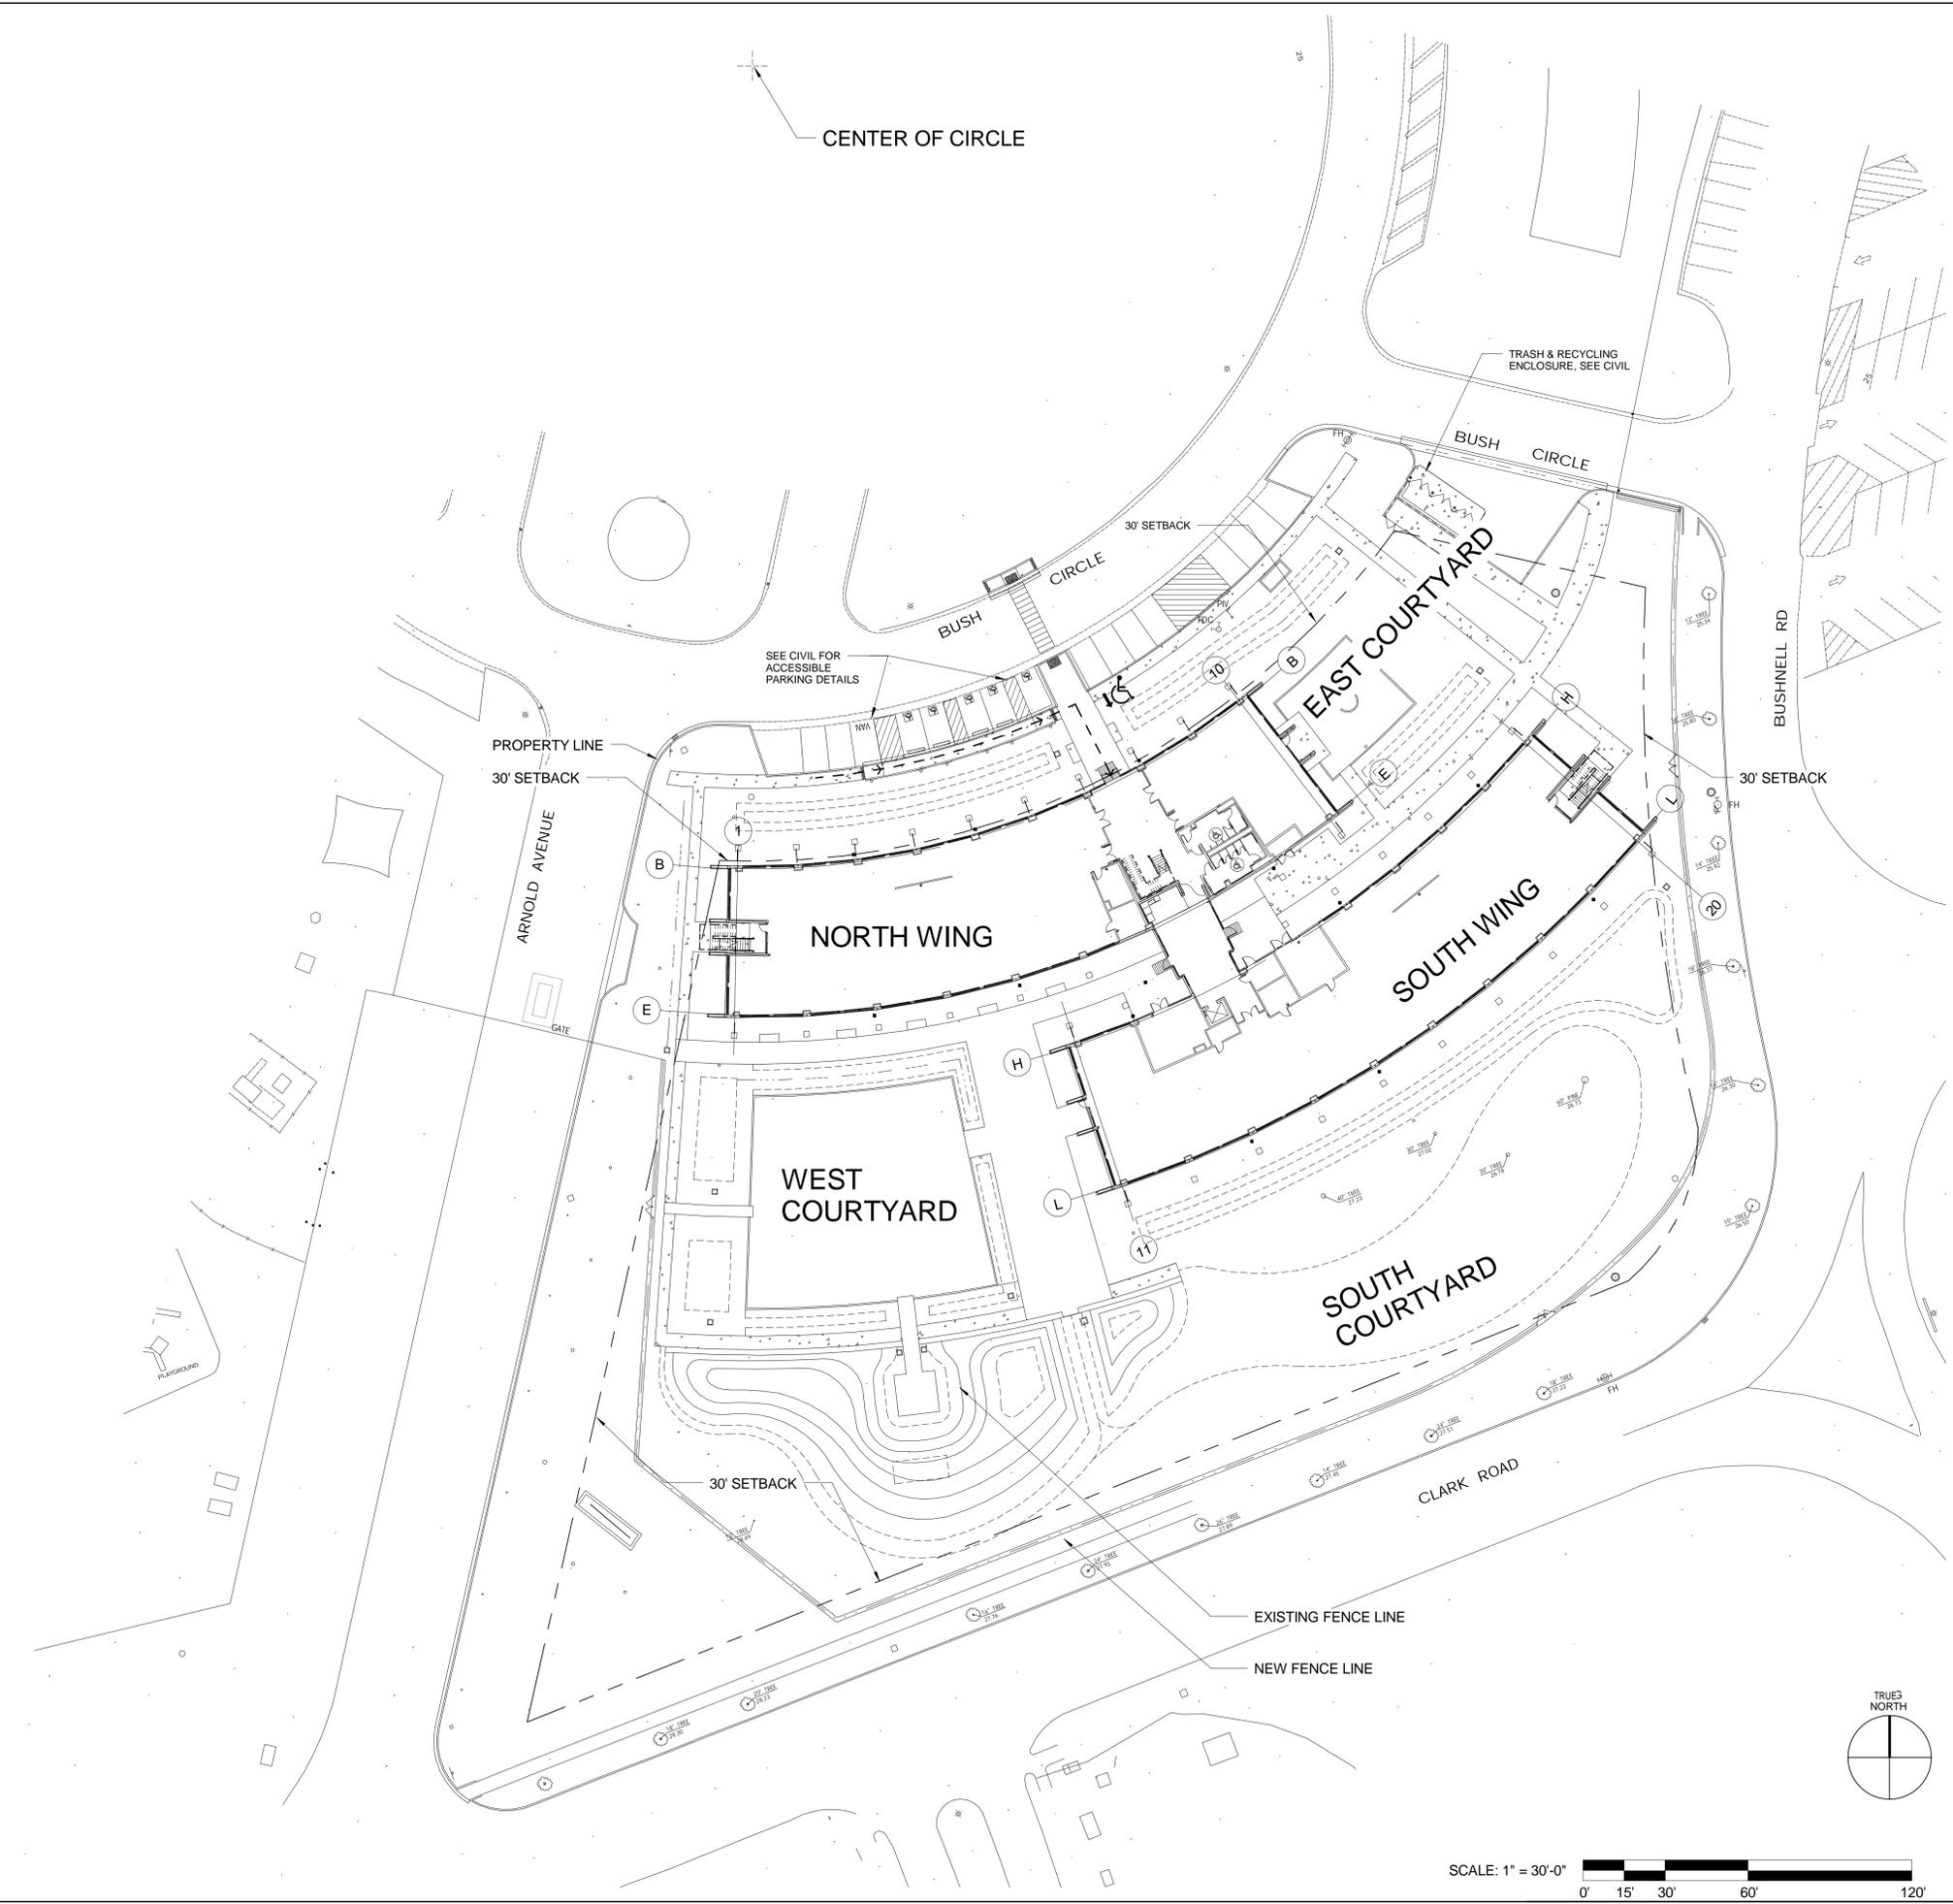

| | | | |
|---|------------|--|-------------|
| PROJECT STATUS | | BID SET 04/30/09 | |
| ISSUE | | | |
| MARK | DATE | DESCRIPTION | INITIAL |
| DRAWN | G JOHNSON | DATE | |
| DESIGNED | R PRADHAN | DATE | |
| CHECKED | W JOFFRION | DATE | |
| PROJECT MGR | J GRANT | DATE | |
| REQUESTOR | R SCHULER | DATE | |
| R&GA | | DATE | |
| SAFETY | | DATE | |
| SUPERVISOR | S FRANKEL | DATE | |
| Ames Research Center Moffet Field, California | | N232 COLLABORATIVE SUPPORT FACILITY ACCESSIBILITY SITE PLAN | |
| SIZE | D | CAUSE CODE | 25307 |
| SCALE | | INDEX | A232-0800- |
| | | SHEET | G100 |
| | | OF | |




4/30/2009 1:16:51 PM

SPACE PLAN LEGEND

SEE SHEET A105 FOR FURTHER FINISH INFORMATION

-  CARPET TILE (FIELD), (CPT-1)
-  CARPET TILE (ACCENT), (CPT-2)
-  VINYL FLOORING (VCT-1)
-  RECLAIMED WOOD STRIP FLOORING (WD-1)

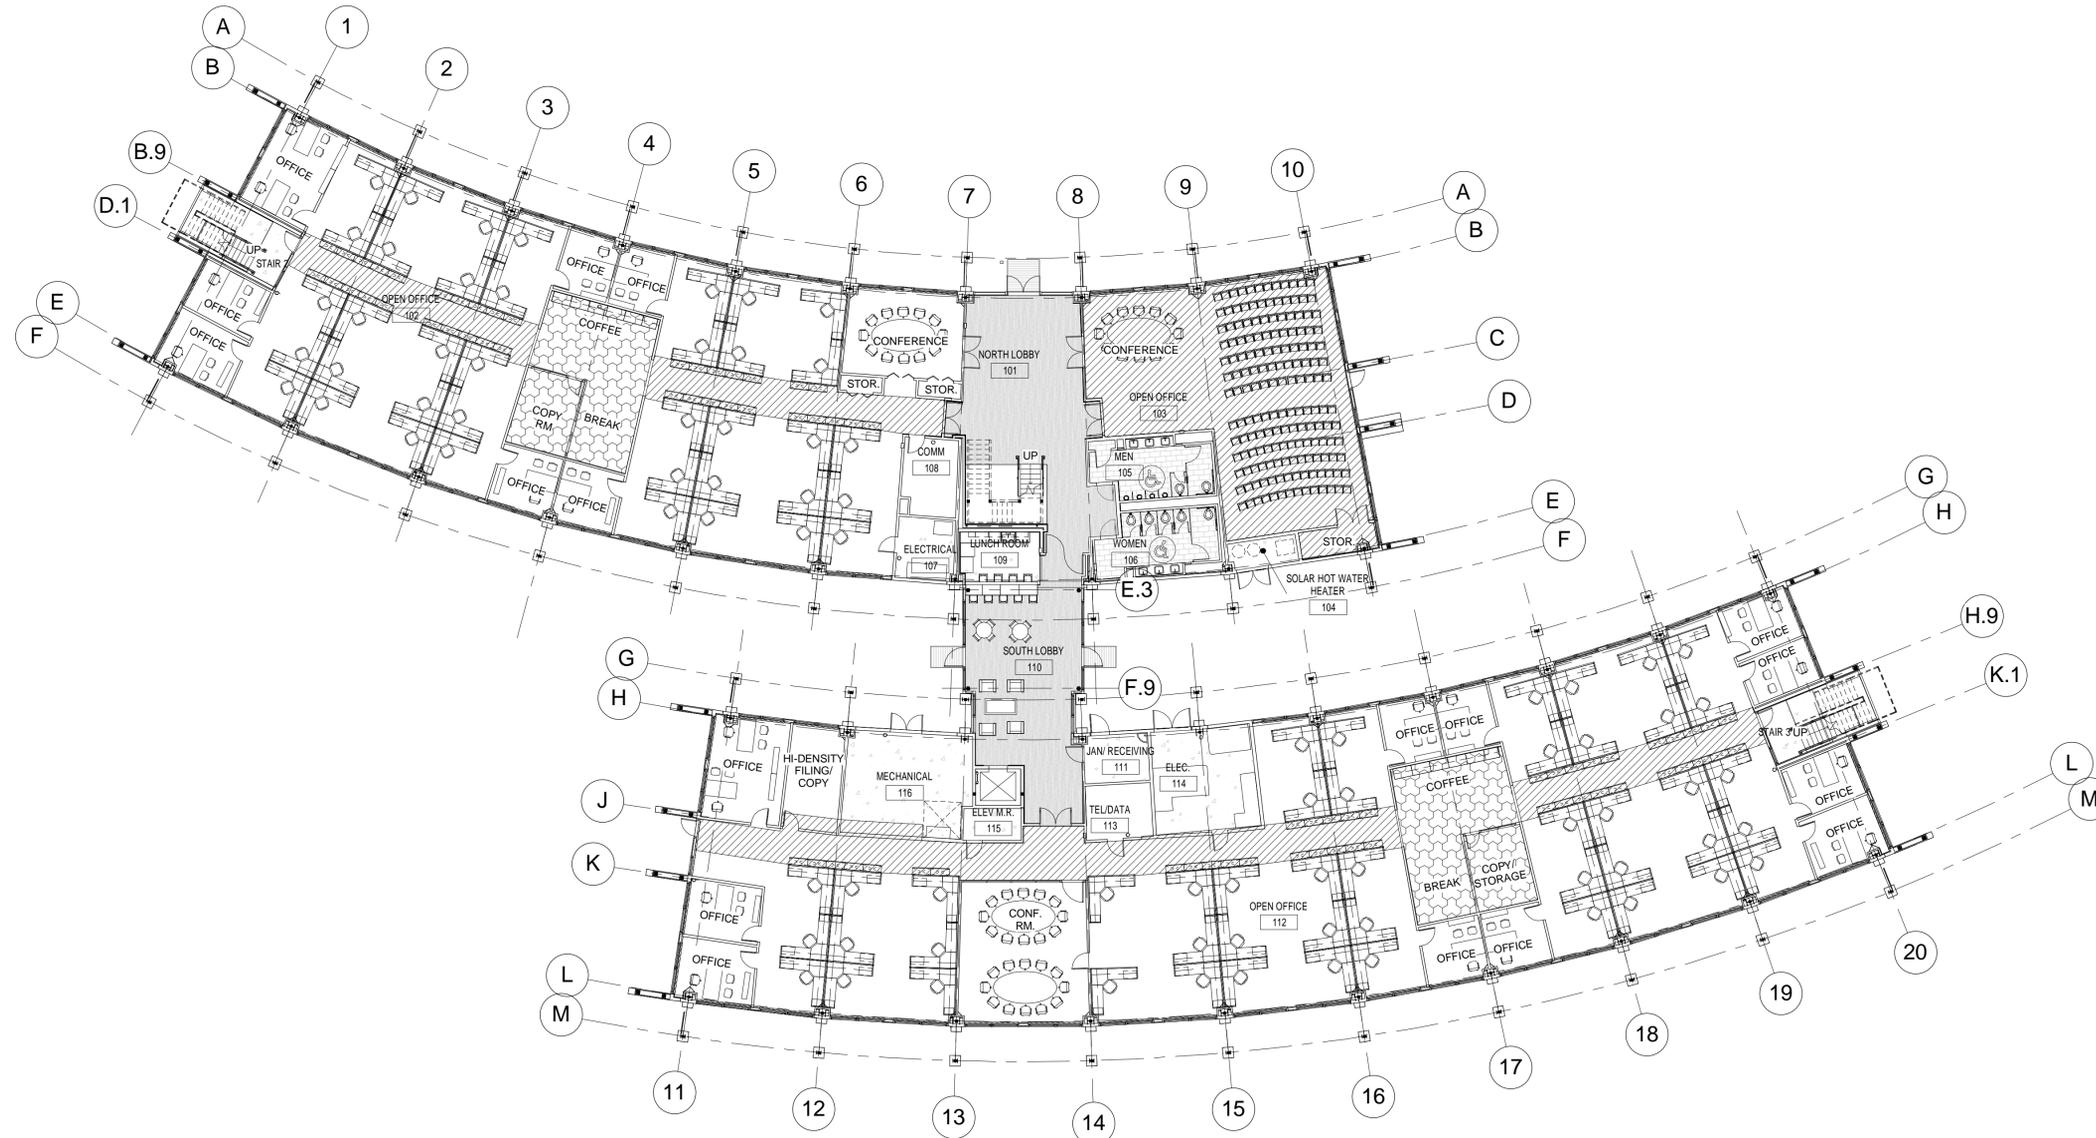

**NOTE: FOR REFERENCE ONLY.
FURNITURE AND INTERIOR
PARTITIONS NOT IN CONTRACT**



SCALE: 1/16" = 1'-0"
0' 8' 16' 32' 64'

| | | | |
|---|------------|--|-------------|
| PROJECT STATUS | | BID SET 04/30/09 | |
| ISSUE | | | |
| MARK | DATE | DESCRIPTION | INITIAL |
| DRAWN | G JOHNSON | DATE | |
| DESIGNED | R PRADHAN | DATE | |
| CHECKED | W JOFFRION | DATE | |
| PROJECTOR | J GRANT | DATE | |
| REQUESTOR | R SCHULER | DATE | |
| REQA | | DATE | |
| SAFETY | | DATE | |
| SUPERVISOR | S FRANKEL | DATE | |
|  Ames Research Center Moffet Field, California | | N232 COLLABORATIVE SUPPORT FACILITY OVERALL SPACE PLAN - FIRST FLOOR | |
| SIZE | D | CAUSE CODE | 25307 |
| SCALE | | INDEX | A232-0800- |
| | | SHEET | G101 |
| | | OF | |

