

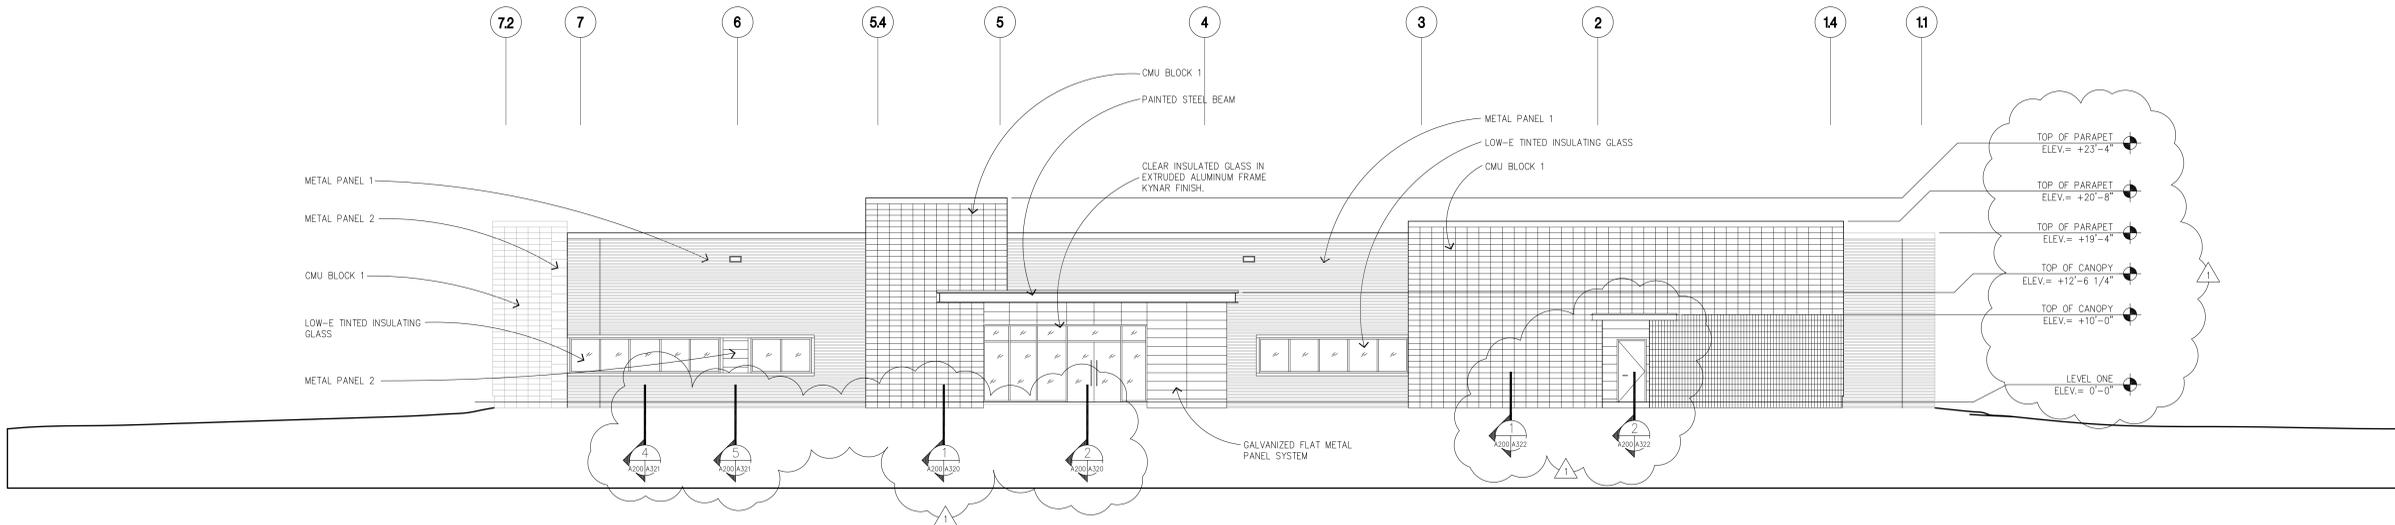


WIND PRESSURE DIAGRAMS

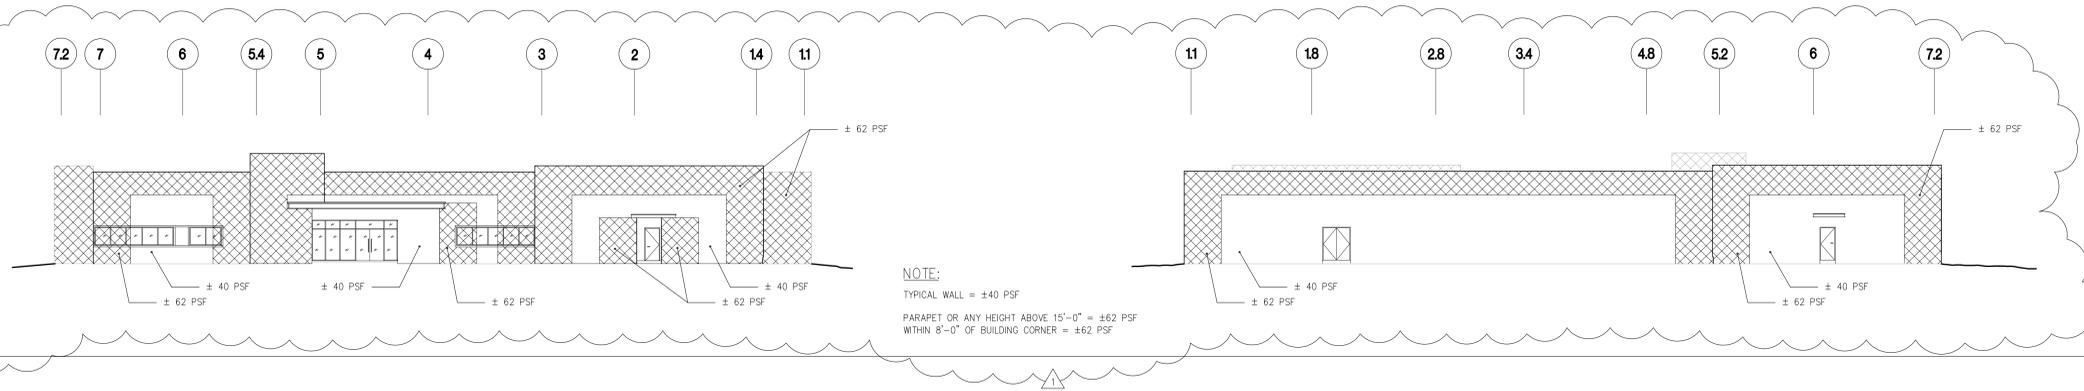


1 NORTH ELEVATION  
A101/A200 SCALE: 1/8"=1'-0"

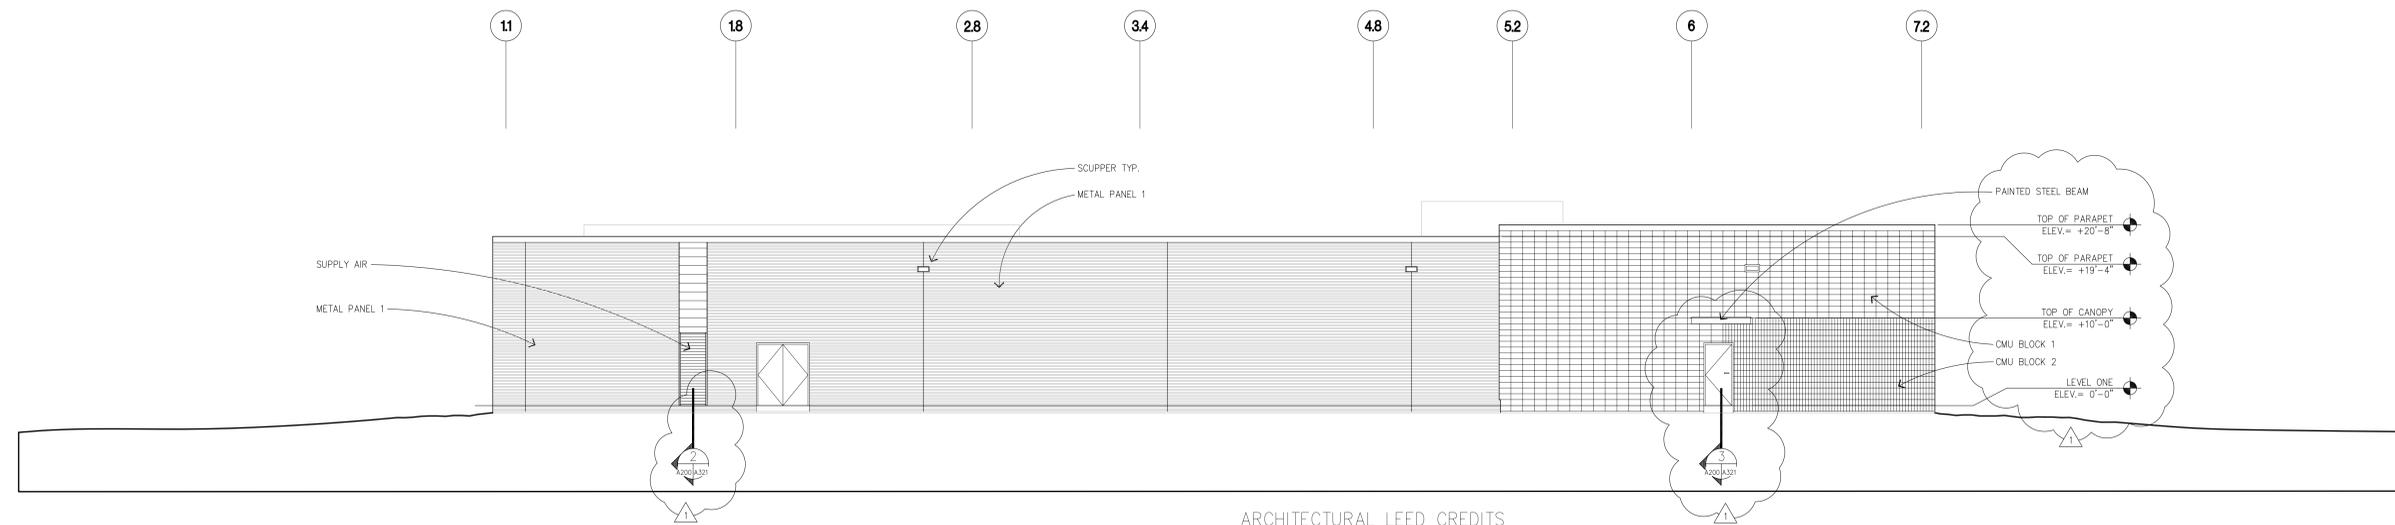

2 SOUTH ELEVATION  
A101/A200 SCALE: 1/8"=1'-0"

ARCHITECTURAL LEED CREDITS  
(PARTIAL LIST)

| REFERENCE | DESCRIPTION  |
|-----------|--|
| MR-4.1    | Specify a minimum of 25% of building materials as recycled. - This is not difficult with concrete and steel, etc.  |
| MR-4.2    | Specify an additional 25% of building materials as recycled. - By weighted average the concrete, cmu, steel, carpet, and other materials should meet this objective.   |
| MR-5.1    | Specify a minimum of 20% of building materials that are manufactured within a radius of 500 miles. - Easy for the Houston market.  |
| MR-5.2    | Of these regionally manufactured materials, specify a minimum of 50% extracted, harvested, or recovered within a 500 mile radius. - More difficult but due to the materials specified, it is achievable.                     |
| MR-7      | Use a minimum of 50% or wood based materials certified in accordance with the Forest Stewardship Council guidelines for wood building components. - Certified wood is available and there is not much used for this project. |

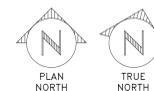

**morris**  
architects

3355 W. Alabama, Suite 200 • Houston, Texas 77098  
713.622.1180 phone • 713.622.7021 fax  
www.morrisarchitects.com • fsp.morrisarchitects.com



| REVISION | DATE    | ADDENDUM NO.   | DESCRIPTION  |
|----------|---------|----------------|--|
| 1        | 8/29/03 | ADDENDUM NO. 1 |  |
| DR.      | ENG     | DATE           | NATIONAL AERONAUTICS & SPACE ADMINISTRATION<br>LYNDON B. JOHNSON SPACE CENTER HOUSTON, TEXAS |
| CH       | APPR    |                |  |
| REV      |         |                |  |
| DISCP    |         |                | BUILDING 27<br>ASTRONAUT QUARANTINE FACILITY<br>EXTERIOR<br>ELEVATIONS                       |
| PE       |         |                | PROJECT NO. 02104 SHEET NO. A-27-02104_g_DF_24   |
| APPR     |         |                | PROJECT ID: 02104 DWG NO. A-27-200   |
|          |         |                | CODE IDENT. NO. 2116 SIZE 11x17  |